



# Snyderville Basin Water Reclamation District

SNYDERVILLE BASIN WATER RECLAMATION DISTRICT  
PARK CITY, UTAH

EAST CANYON WATER RECLAMATION FACILITY


DEWATERING EQUIPMENT INSTALLATION

PROJECT NO. 204042

ADDENDUM NO. 1  
TO THE  
CONTRACT DOCUMENTS

JUNE 2025

Digitally signed by Erin R. Andersen  
Contact Info: Carollo Engineers, Inc.  
Date: 2025.06.02 09:51:07-06'00'

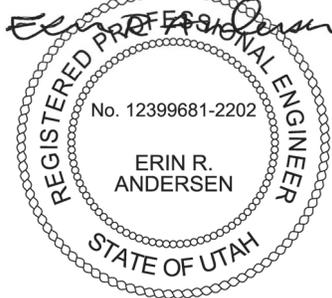

Bidders on the above-named project are hereby notified that the Bidding Documents are modified as indicated below. Bidders are required to acknowledge receipt of this Addendum in the space provided on the Document 00410 - Bid Form.

This Addendum shall become part of the Contract and provisions of the Contract apply.

## **DRAWINGS**

1. Drawing 00G05:
  - a. Replace this drawing with the attached drawing 00G05.
2. Drawing 00GS01:
  - a. Replace this drawing with the attached drawing 00GS01.
3. Drawing 00S01:
  - a. Replace this drawing with the attached drawing 00S01.
4. Drawing 00S02:
  - a. Replace this drawing with the attached drawing 00S02.
5. Drawing 00S03:
  - a. Replace this drawing with the attached drawing 00S03.
6. Drawing 00TS03:
  - a. Replace this drawing with the attached drawing 00TS03.
7. Drawing 00M03:
  - a. Add new keynote 11 with callout to the new aluminum platform south of the new equipment:

“Provide new aluminum platform as two pieces, one half to be installed following the installation of Rotary Press 1 and the other to be installed following the installation of Rotary Press 2 to avoid conflict with existing equipment. See structural sheets for details.”

PIPING SCHEDULE											
FLOW STREAM IDENTIFIER	SERVICE	PIPE SIZE (1)	MATERIAL	PRESSURE CLASS/WALL THICKNESS	PIPE SPEC. SECTION	JOINTS/FITTINGS	LINING	COATING	TESTING		NOTES
									METHOD	PRESSURE (PSI)	
CA	COMPRESSED AIR										
	EXPOSED	2" AND LESS	BSP	SCH 40		SCRD, FL, GE			AM	150	
D	DRAINS										
	BURIED	ALL SIZES	PVC	SCH 40 DWV	15400	SW			GR		
	EXPOSED	ALL SIZES	PVC	SCH 40 DWV	15400	SW			GR		
PD	PROCESS DRAIN										
	EXPOSED	LESS THAN 4"	PVC	SCH 80	15249	SW/FL			LH	10	
	EXPOSED	4" AND LARGER	DIP	DIPRA 150	15211	FL/GE	CM		LH	10	
POL	POLYMER										
	EXPOSED	ALL SIZES	PVC	SCH 80	15230	SW			HH	50	
UW	UTILITY WATER										
	EXPOSED	ALL SIZES	PVC	SCH 80	15249	SW/FL			HH	150	
V	VENT										
	EXPOSED	ALL SIZES	PVC	SCH 40 DWV	15400	SW/FL			GR		
WAS	WASTE ACTIVATED SLUDGE										
	EXPOSED	ALL SIZES	DIP	DIPRA 150	15211	FL or GE	CM		HH	30	

NOTES:  
(1) NOMINAL DIAMETER (INCHES)

PIPE MATERIAL AND JOINT/FITTING ABBREVIATIONS:

BW BUTT WELD  
 B&SP BELL AND SPIGOT  
 BSP BLACK STEEL PIPE  
 BF BARBED FITTING  
 CF COMPRESSION FITTING  
 CI CAST IRON  
 CISP CAST IRON SOIL PIPE  
 CL  
 CM CEMENT MORTAR  
 CTP COAL TAR PITCH  
 DIP DUCTILE IRON PIPE  
 DWV DRAIN, WASTE AND VENT  
 FL FLANGE  
 FRP FIBERGLASS PIPE  
 GA GAUGE, PRECEDED BY THE DESIGNATION  
 GE GROOVED END PIPE  
 GSP GALVANIZED STEEL PIPE  
 MJ MECHANICAL JOINT  
 MDPE MEDIUM PRESSURE POLYETHENE  
 NPS NOMINAL PIPE SIZE, FOLLOWED BY THE NUMBER IN INCHES  
 PE POLYETHYLENE  
 PTC PUSH-TO-CONNECT  
 PVC POLYVINYL CHLORIDE  
 R-B&SP RESTRAINED BELL AND SPIGOT  
 RMJ RESTRAINED MECHANICAL JOINT  
 RPVC REINFORCED POLYVINYL CHLORIDE TUBING  
 SCH SCHEDULE, FOLLOWED BY THE DESIGNATION  
 SCR D SCREWED-ON/THREADED  
 SST STAINLESS STEEL  
 SW SOLVENT WELD

LINING AND COATING ABBREVIATIONS:


ACR ACRYLIC COATING  
 CM CEMENT MORTAR  
 CP CARRIER PIPE  
 EPP EPOXY POLYURETHANE COATING  
 FA FIELD APPLIED COATING  
 GC GEL COAT  
 GL GLASS LINED  
 HSE HIGH SOLIDS EPOXY  
 I INSULATED (ONLY)  
 P PAINTED  
 POL POLYETHYLENE LINED  
 PE POLYETHYLENE-WRAPPED  
 PEE POLYETHYLENE ENCASEMENT  
 PVC POLYVINYL CHLORIDE  
 CE CERAMIC EPOXY  
 CT COAL TAR ENAMEL  
 CTX COAL TAR EPOXY  
 TW TAPE WRAPPED  
 FP FLUOROPOLYMER  
 R RUBBER LINING  
 EPX EPOXY LINED

TEST PRESSURE METHOD:

AM AIR METHOD  
 GR GRAVITY METHOD  
 HH HIGH HEAD METHOD  
 LH LOW HEAD METHOD  
 SC SPECIAL CASE

LAST SAVED BY: rleitz

DESIGNED	EA
DRAWN	TJD
CHECKED	CTA
DATE	MAY 2025
REV	05/25/25
DATE	EA
BY	ADDENDUM #1
DESCRIPTION	

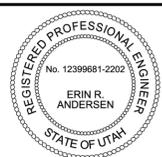

SNYDERVILLE BASIN WATER RECLAMATION DISTRICT  
 DEWATERING EQUIPMENT PREPURCHASE  
 GENERAL  
 PIPE SCHEDULE

VERIFY SCALES  
 BAR IS ONE INCH ON ORIGINAL DRAWING  
 0 1"  
 IF NOT ONE INCH ON THIS SHEET, ADJUST SCALES ACCORDINGLY

JOB NO. 204042  
 DRAWING NO. 00G05  
 SHEET NO. 5 OF 42




**GENERAL NOTES:**


1. FOR STRUCTURAL GENERAL NOTES SEE DRAWING 00GS01.

**# KEY NOTES:**

1. NEW FOOTING. TOP FLUSH WITH EXISTING FINISHED FLOOR.
2. CONTRACTOR FIELD VERIFY THAT HEIGHT AND LENGTH ARE SUFFICIENT TO CLEAR THE SCREW CONVEYOR.
3. HANDRAIL EXTENSION NOT REQUIRED.
4. #4 X 4'-0" LONG CORNER BARS T&B

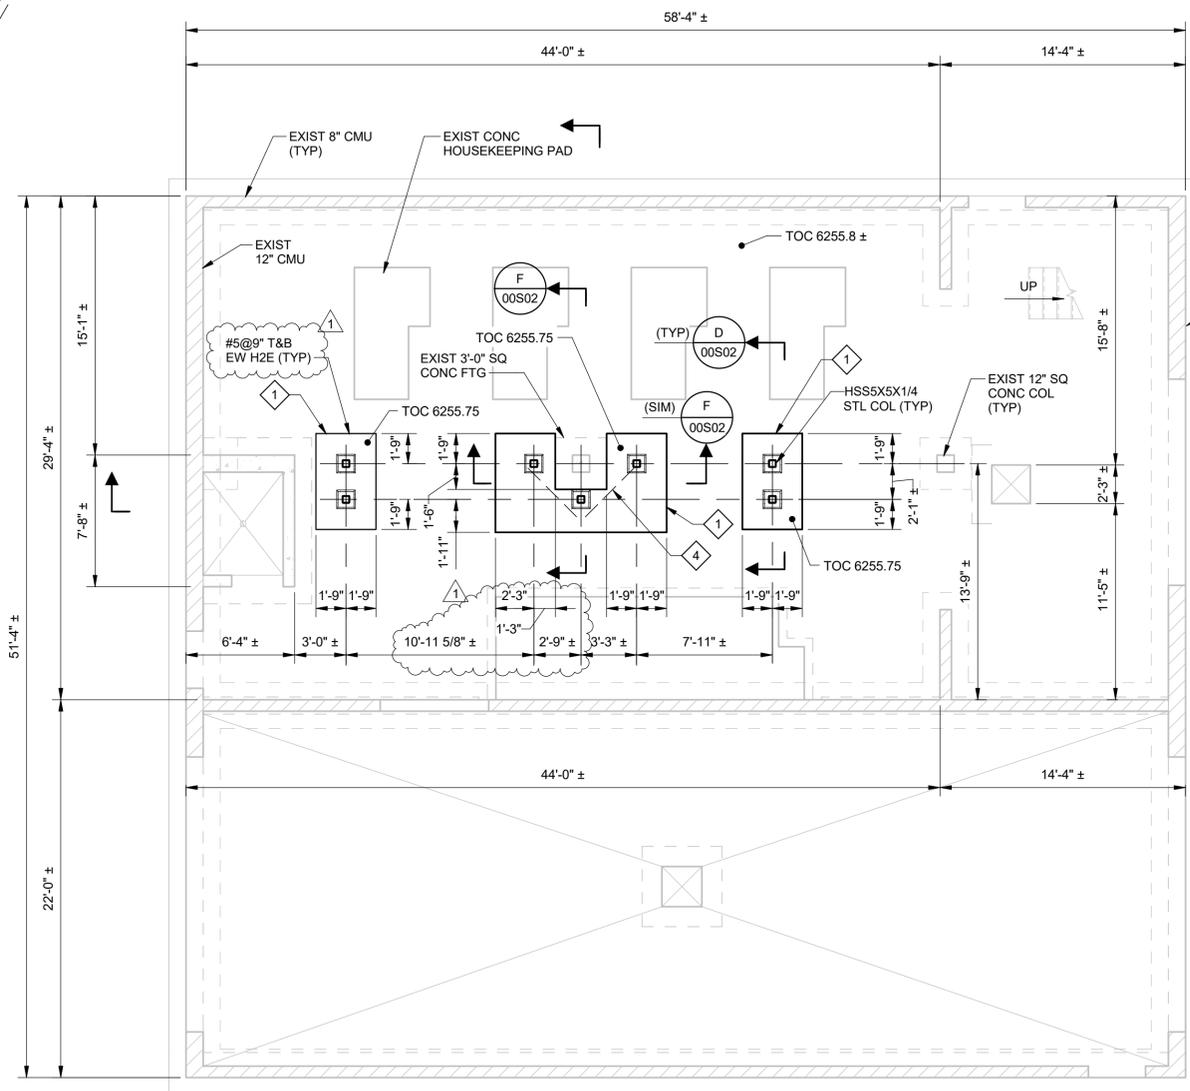

**FOUNDATION PLAN**  
**A** SCALE: 3/16" = 1'-0"

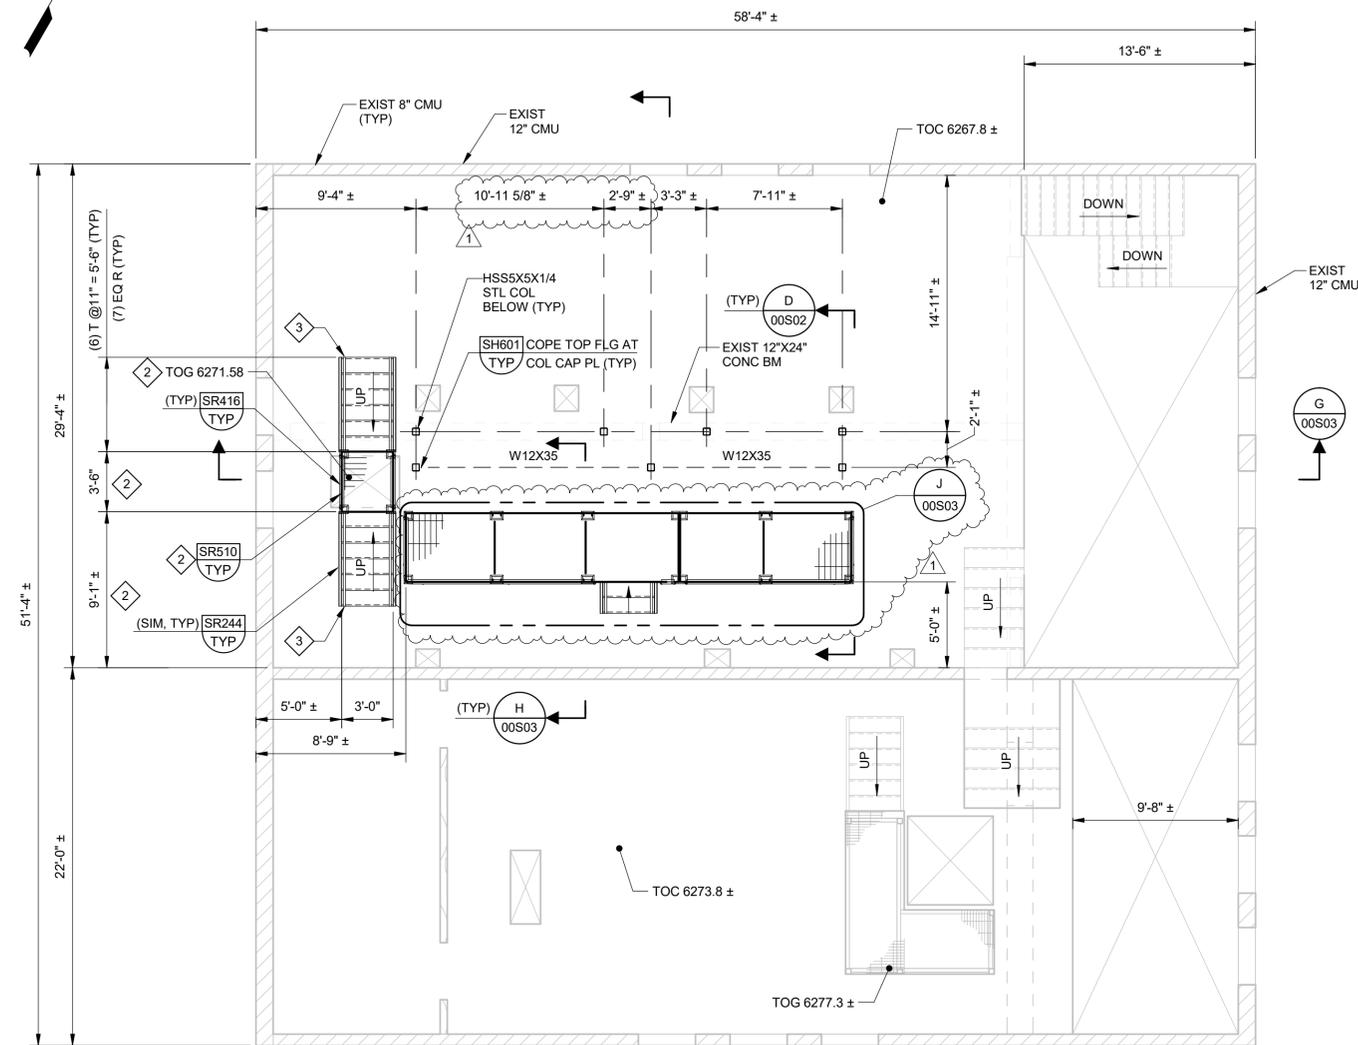

**UPPER PLAN**  
**B** SCALE: 3/16" = 1'-0"

PLOT DATE: 5/30/2025 11:33:02 AM

REV	DATE	BY	DESCRIPTION
1	05/25/25	EA	ADDENDUM #1


DESIGNED CB
DRAWN TJD
CHECKED JMY
DATE MAY 2025



SNYDERVILLE BASIN WATER RECLAMATION DISTRICT  
 DEWATERING EQUIPMENT PREPURCHASE  
 STRUCTURAL  
**SOLIDS BUILDING PLANS**

VERIFY SCALES  
 BAR IS ONE INCH ON ORIGINAL DRAWING  
 0 1"  
 IF NOT ONE INCH ON THIS SHEET, ADJUST SCALES ACCORDINGLY

JOB NO. 204042  
 DRAWING NO. 00S01  
 SHEET NO. 13 OF 42

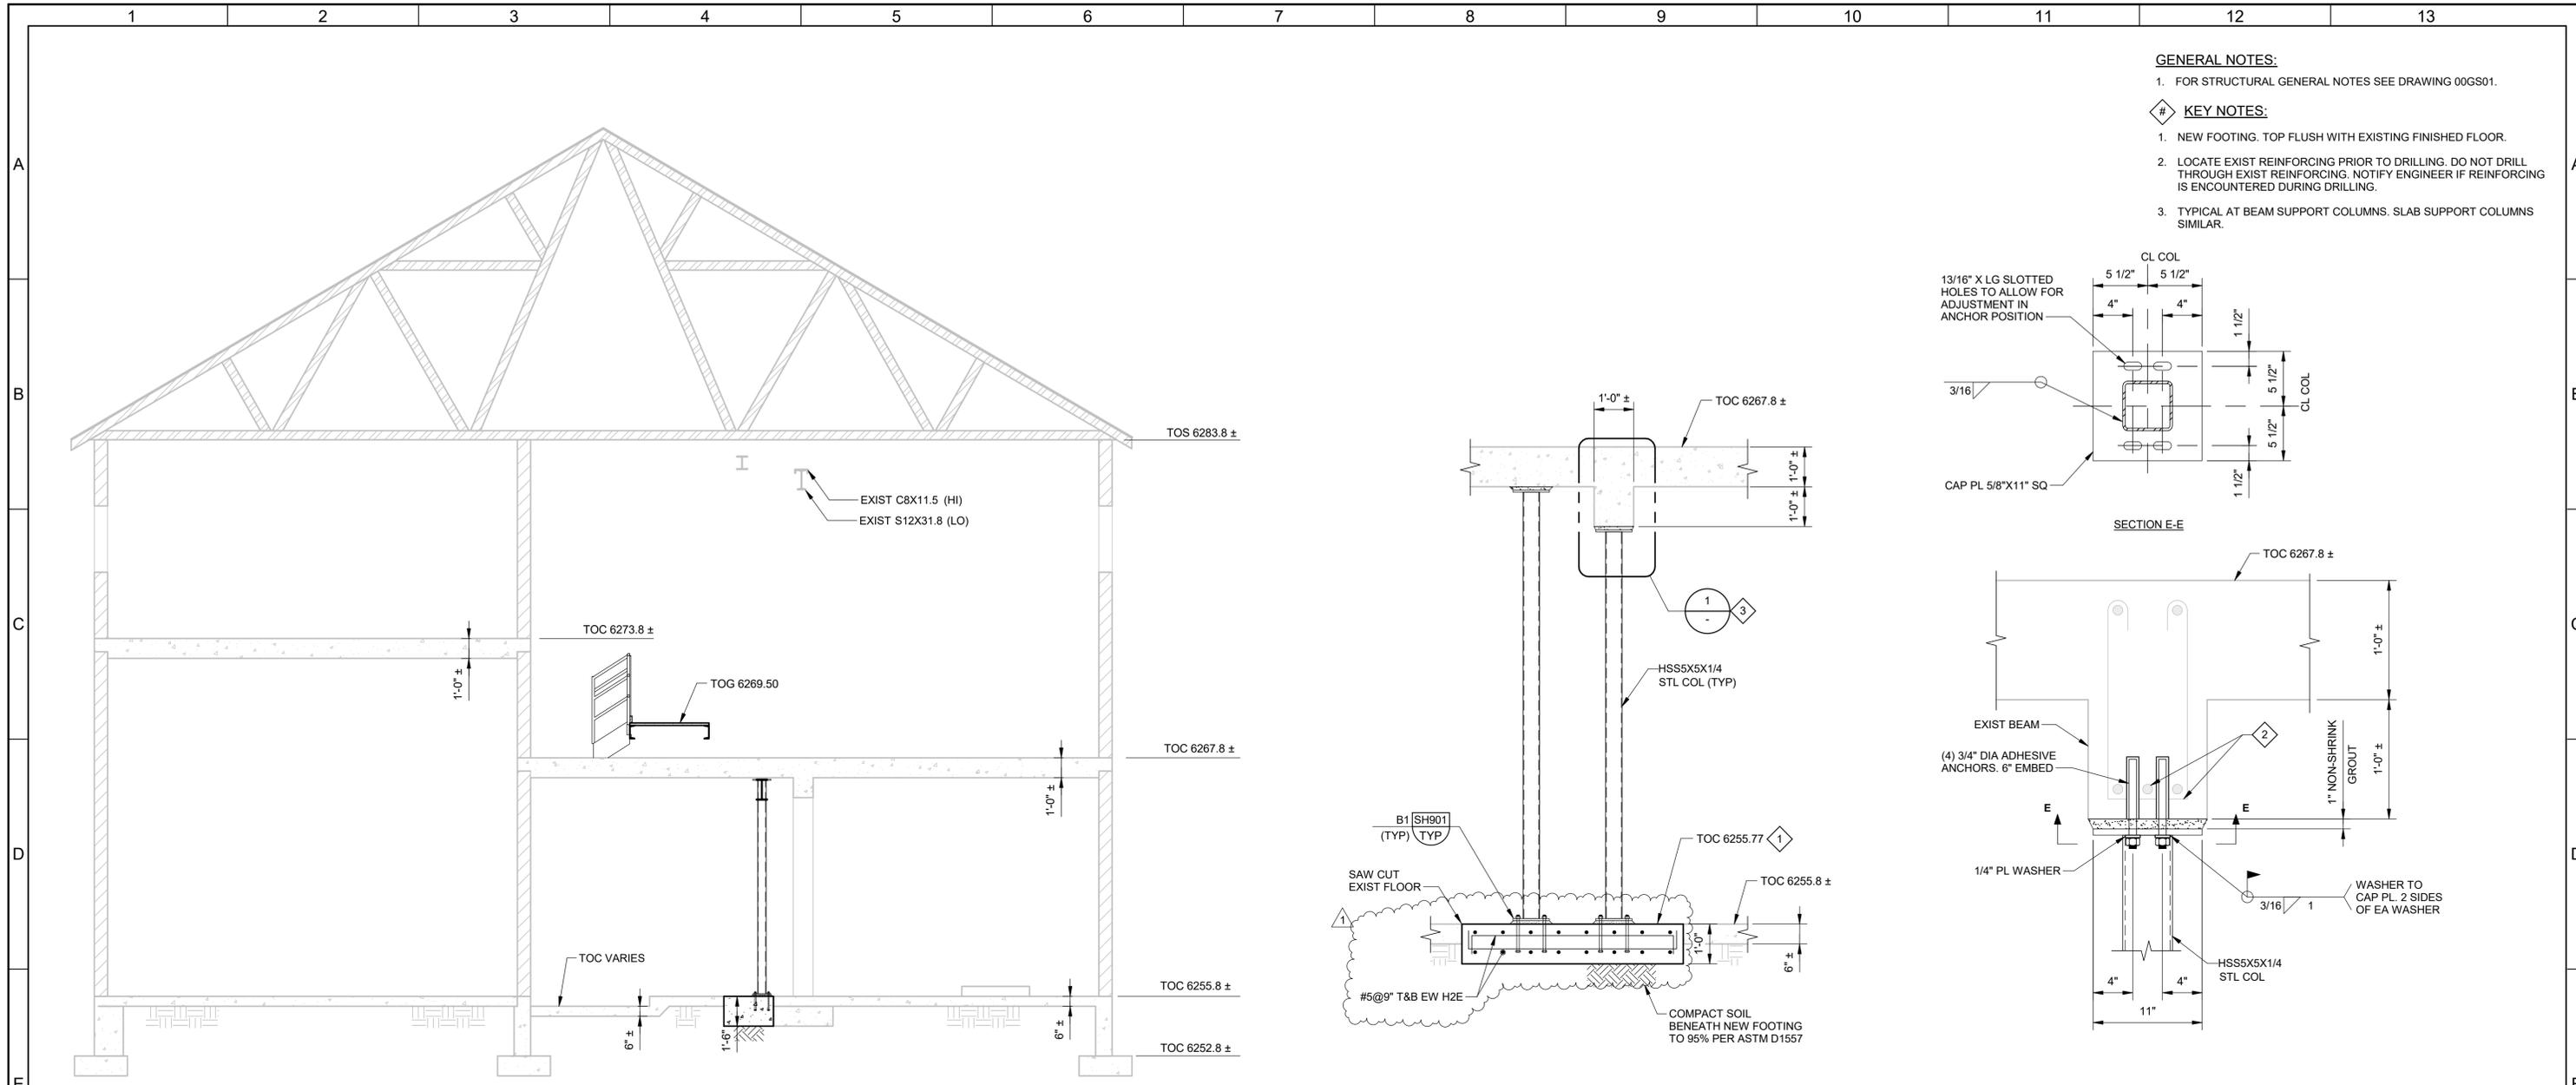

- GENERAL NOTES:**
- FOR STRUCTURAL GENERAL NOTES SEE DRAWING 00GS01.
- KEY NOTES:**
- NEW FOOTING. TOP FLUSH WITH EXISTING FINISHED FLOOR.
  - LOCATE EXIST REINFORCING PRIOR TO DRILLING. DO NOT DRILL THROUGH EXIST REINFORCING. NOTIFY ENGINEER IF REINFORCING IS ENCOUNTERED DURING DRILLING.
  - TYPICAL AT BEAM SUPPORT COLUMNS. SLAB SUPPORT COLUMNS SIMILAR.

**C SECTION**  
00S01 SCALE: 1/4" = 1'-0"

**D SECTION**  
00S01 SCALE: 1/2" = 1'-0"

**1 DETAIL**  
SCALE: 1 1/2" = 1'-0"

**F SECTION**  
00S01 SCALE: 1/2" = 1'-0"

REV	DATE	BY	DESCRIPTION
1	05/25/25	EA	ADDENDUM #1

DESIGNED CB	
DRAWN TJD	
CHECKED JMY	
DATE MAY 2025	



SNYDERVILLE BASIN WATER RECLAMATION DISTRICT  
DEWATERING EQUIPMENT PREPURCHASE  
STRUCTURAL  
**SOLIDS BUILDING  
SECTIONS AND DETAILS 1**

VERIFY SCALES BAR IS ONE INCH ON ORIGINAL DRAWING 0 1"	JOB NO. 204042
IF NOT ONE INCH ON THIS SHEET, ADJUST SCALES ACCORDINGLY	DRAWING NO. <b>00S02</b>
	SHEET NO. 14 OF 42


PLOT DATE: 5/30/2025 11:26:03 AM

**GENERAL NOTES:**


1. FOR STRUCTURAL GENERAL NOTES SEE DRAWING 00GS01.

**KEY NOTES:**


- 1. NEW FOOTING, TOP FLUSH WITH EXISTING FINISHED FLOOR.
- 2. HANDRAIL EXTENSION NOT REQUIRED.

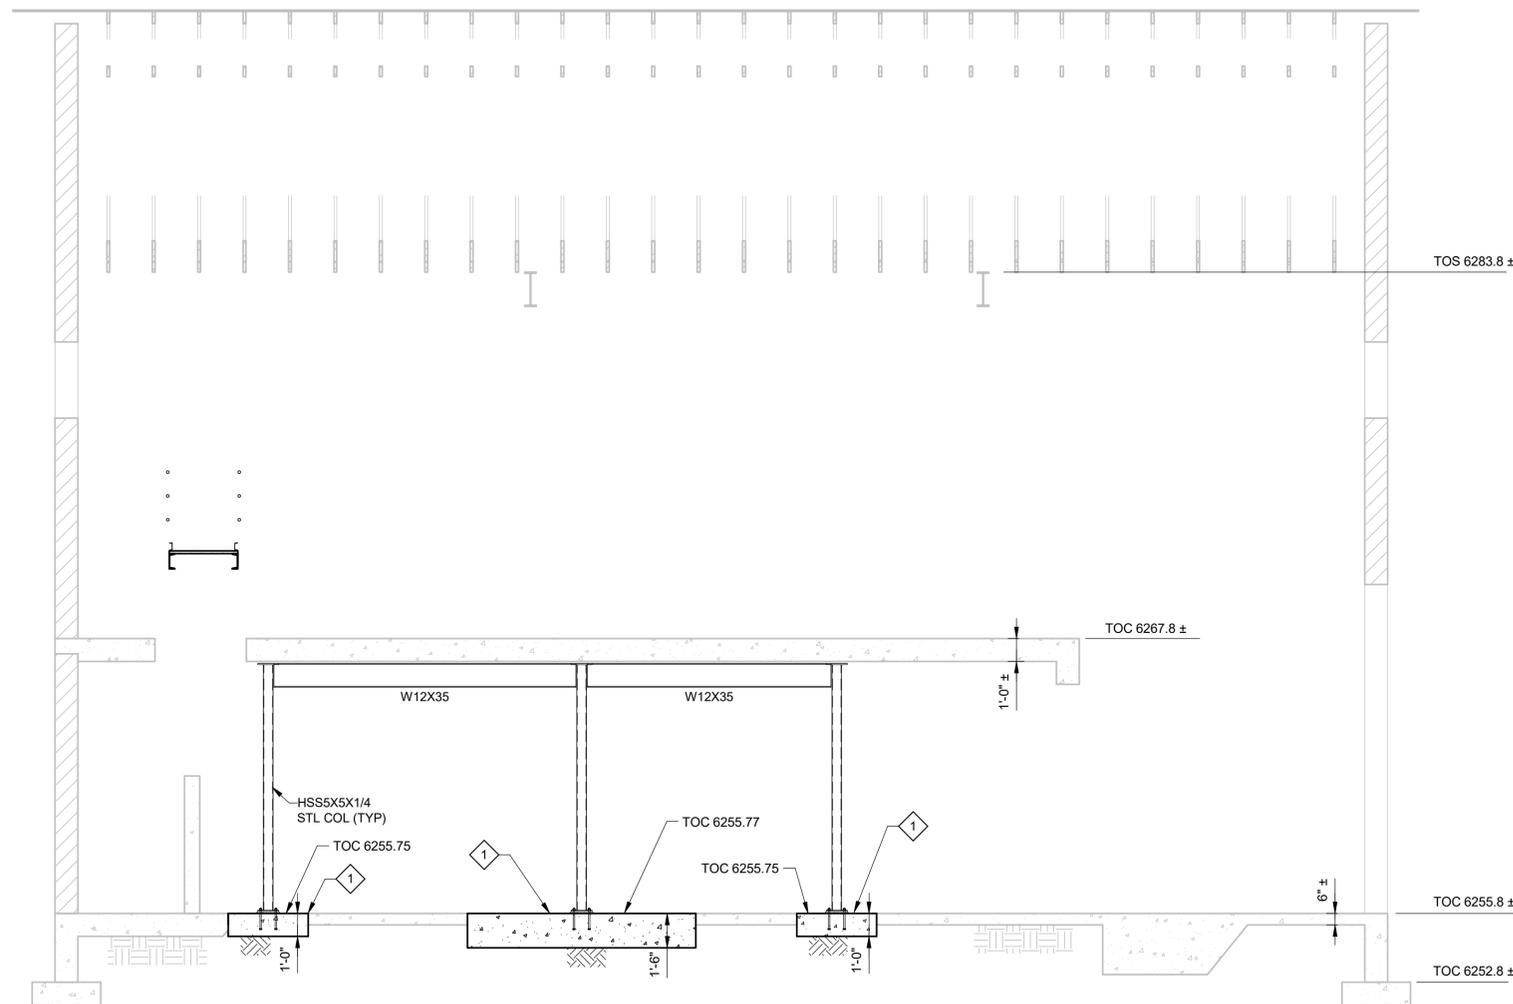

**G SECTION**  
00S01 SCALE: 1/4" = 1'-0"

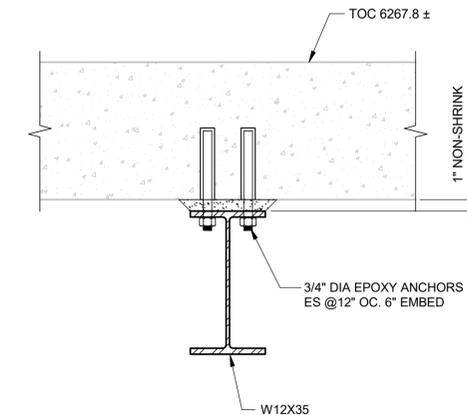

**H SECTION**  
00S01 SCALE: 1 1/2" = 1'-0"

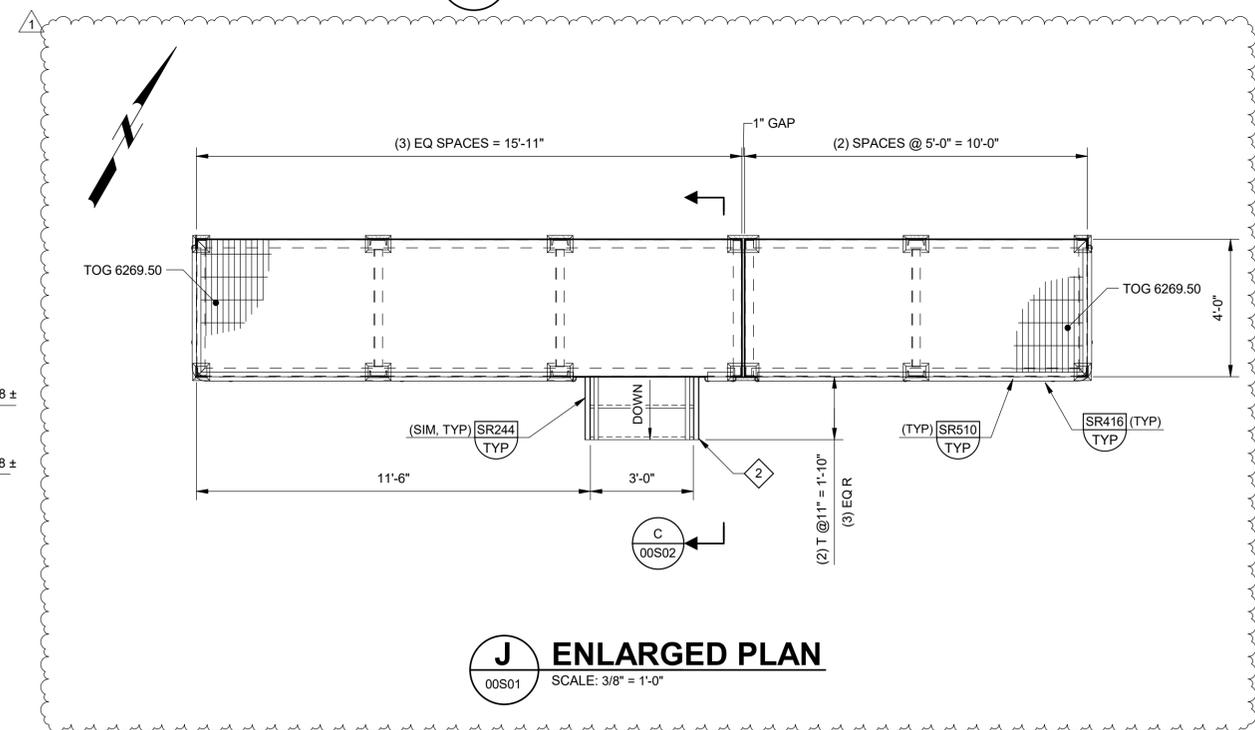

**J ENLARGED PLAN**  
00S01 SCALE: 3/8" = 1'-0"

PLOT DATE: 5/30/2025 11:26:04 AM

REV	DATE	BY	DESCRIPTION
1	05/25/25	EA	ADDENDUM #1


DESIGNED CB
DRAWN TJD
CHECKED JMY
DATE MAY 2025




SNYDERVILLE BASIN WATER RECLAMATION DISTRICT  
DEWATERING EQUIPMENT PREPURCHASE  
STRUCTURAL  
**SOLIDS BUILDING  
SECTIONS AND DETAILS 2**

VERIFY SCALES  
BAR IS ONE INCH ON ORIGINAL DRAWING  
0 1"  
IF NOT ONE INCH ON THIS SHEET, ADJUST SCALES ACCORDINGLY


JOB NO.  
204042  
DRAWING NO.  
**00S03**  
SHEET NO.  
15 OF 42

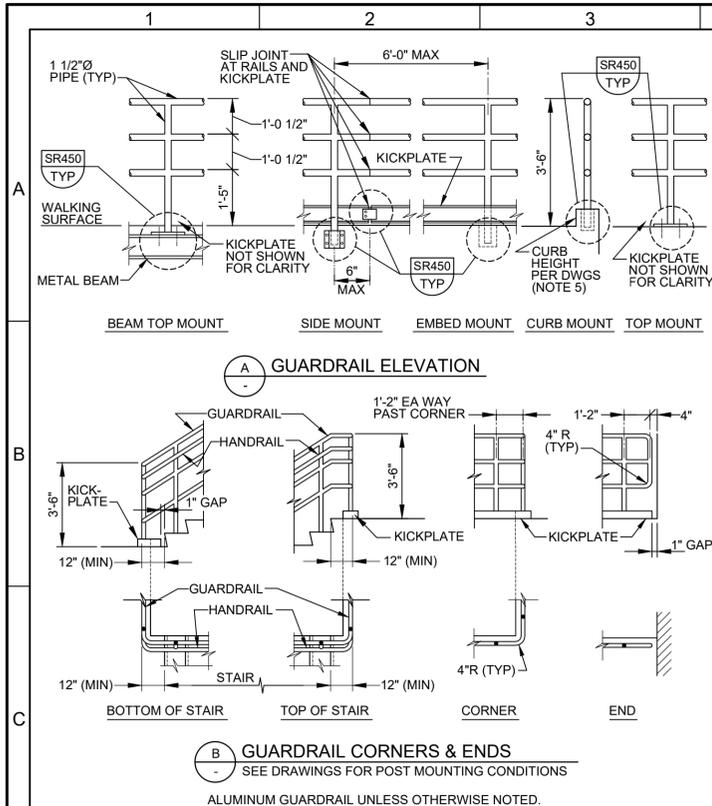


**SR416 GUARDRAIL - 3 RAIL**  
TYP N SHEET 1 OF 3 12/13/2024

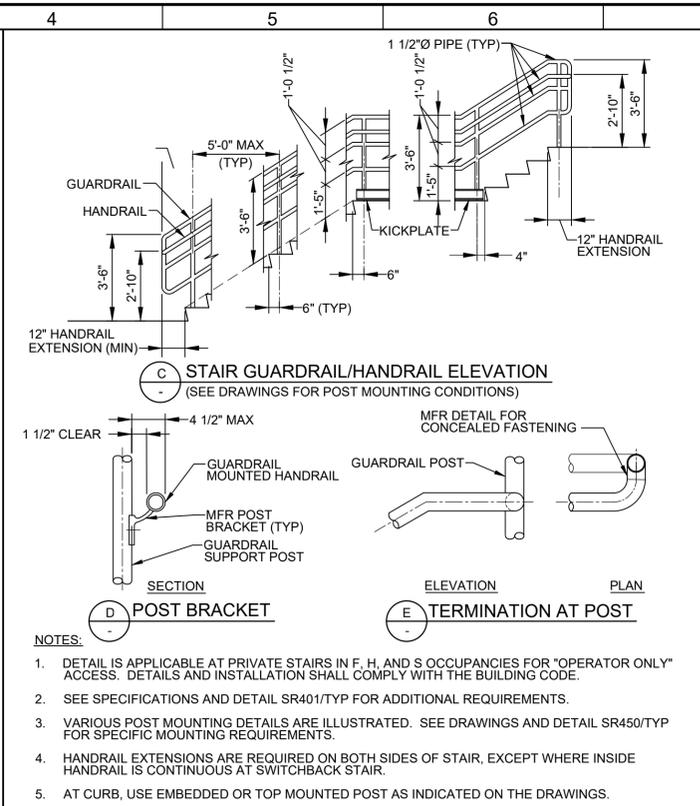


**SR416 GUARDRAIL - 3 RAIL**  
TYP N SHEET 2 OF 3 12/13/2024

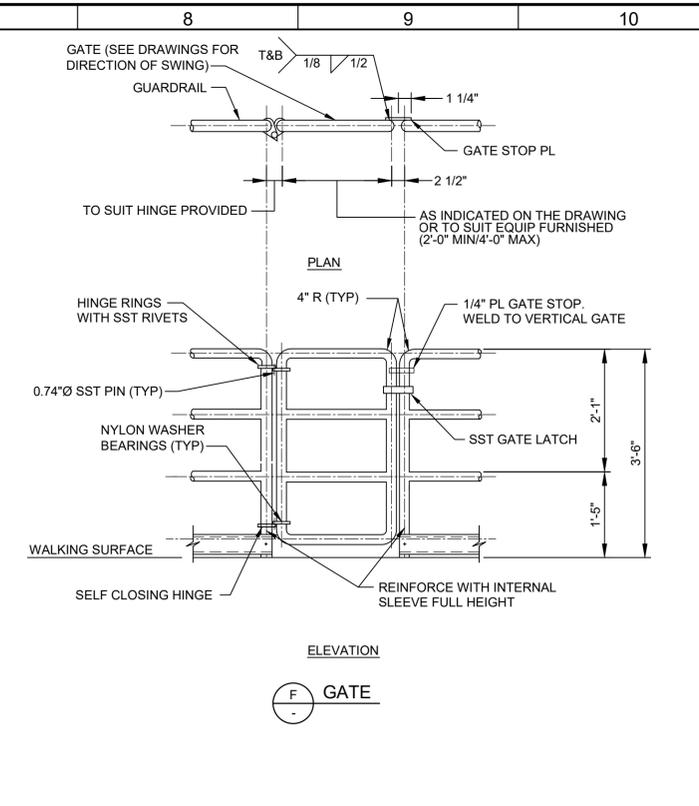


**SR416 GUARDRAIL - 3 RAIL**  
TYP N SHEET 3 OF 3 12/13/2024

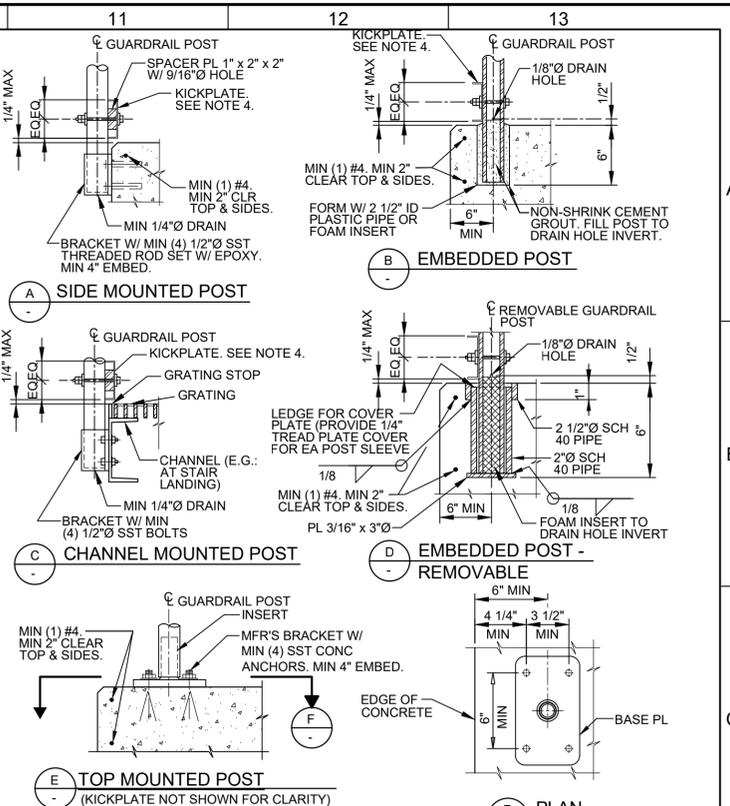


**SR450 GUARDRAIL - POST MOUNTING**  
TYP N SHEET 1 OF 2 09/25/2024

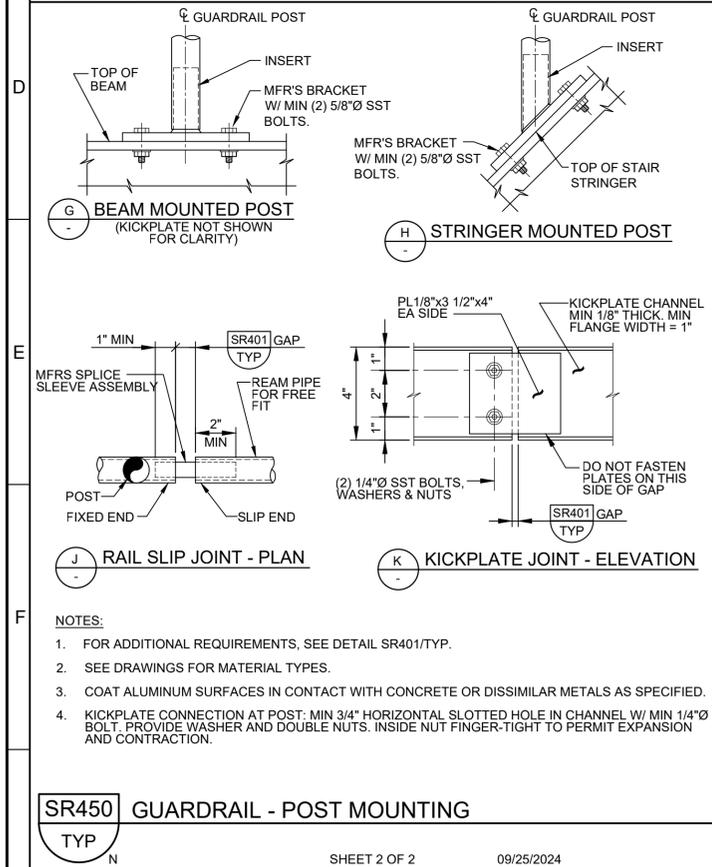

**SR450 GUARDRAIL - POST MOUNTING**  
TYP N SHEET 2 OF 2 09/25/2024

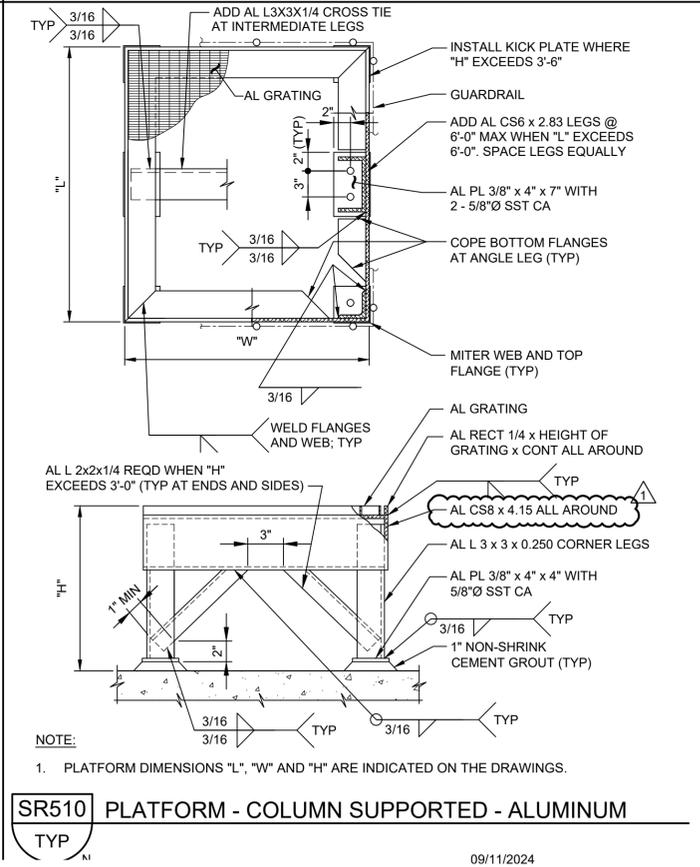


**SR510 PLATFORM - COLUMN SUPPORTED - ALUMINUM**  
TYP N SHEET 1 OF 2 09/11/2024

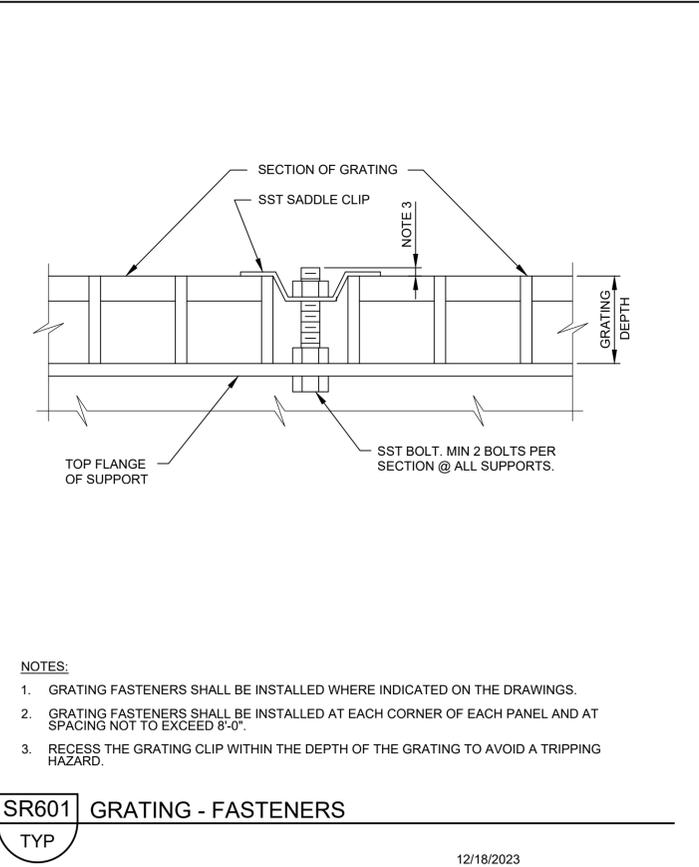

**SR601 GRATING - FASTENERS**  
TYP N SHEET 1 OF 1 12/18/2023

LAST SAVED BY: bteiz

DESIGNED	CE
DRAWN	CE
CHECKED	JMY
DATE	MAY 2025
REV	05/30/25
DATE	EA
BY	ADDENDUM #1
DESCRIPTION	

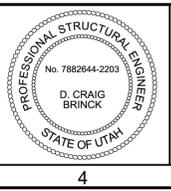

SNYDERVILLE BASIN WATER RECLAMATION DISTRICT  
DEWATERING EQUIPMENT PREPURCHASE  
TYPICAL DETAILS  
**STRUCTURAL 3**

VERIFY SCALES  
BAR IS ONE INCH ON ORIGINAL DRAWING  
0 1"  
IF NOT ONE INCH ON THIS SHEET, ADJUST SCALES ACCORDINGLY

JOB NO. 204042  
DRAWING NO. 00TS03  
SHEET NO. 12 OF 42